

345kV UNDERGROUND TRANSMISSION LINE

Transmission Route Norfolk County, Massachusetts

> <u>AREA MAP</u> <u>MASSACHUSETTS</u> N.T.S.

ABLE GRID PROJECT ENGINEER:

ABLE GRID PROJECT NUMBER:

POWER ENGINEERS

PROJECT ENGINEER: THOMAS BUONOMANO

POWER ENGINEERS

PROJECT NUMBER: 171930



THIS DRAWING WAS PREPARED BY POWER

ENGINEERS, INC. FOR A SPECIFIC PROJECT,
TAKING INTO CONSIDERATION THE SPECIFIC
AND UNIQUE REQUIREMENTS OF THE PROJECT.
REUSE OF THIS DRAWING OR ANY INFORMATION
CONTAINED IN THIS DRAWING FOR ANY PURPOSE
IS PROHIBITED UNLESS WRITTEN PERMISSION
FROM BOTH POWER AND POWER'S CLIENT IS



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									CKD	TPB	11/05/2021	
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REV	REVISIONS	DATE	DRN	DSGN	CKD	APPD	REFERENCE DRAWINGS			R 22x34 DW	G ONLY	

POWER ENGINEERS

JOB NUMBER ABLE GRID PROPOSED 345kV UNDERGROUND TRANSMISSION LINE 171930 DRAWING NUMBER G0 - 1COVER

	DRAWING MANIFEST		
DRAWING NO.	TITLE/DESCRIPTION	REVISION	DATE
G0-1	COVER	А	2/14/2022
G0-2	DRAWING MANIFEST AND GENERAL NOTES	А	2/14/2022
P1-1	PLAN & PROFILE STA. 0+00 TO STA. 8+00	А	2/14/2022
P1-2	PLAN & PROFILE STA. 8+00 TO STA. 14+65	А	2/14/2022
P2-1	EASEMENT OVERVIEW	А	2/14/2022

TRANSITION STRUCTURE DETAILS

2/14/2022

S1-1


GENERAL NOTES

- 1. THE UTILITIES AND NATURAL FEATURES SHOWN HEREON ARE BASED ON:
- GOOGLE EARTH 2020
- GEOTECH BORINGS BY GZA ON 10/18/2021
 MEDWAY BESS INTERCONNECTION DRAWING PROVIDED BY ABLE GRID ENERGY ON 10/25/2021
- UTILITY LOCATES BY GPRS PROVIDED BY ABLE GRID ENERGY ON 10/26/2021
- EXELON MAJOR SITE PLAN SET PROVIDED BY ABLE GRID ENERGY ON 10/26/2021
 SITE SURVEY DONE BY LAND PLANNING, INC, PROVIDED BY ABLE GRID ENERGY ON
- 10/26/2021
- OTHER FACILITIES MAY EXIST NOT DISCOVERED THROUGH THE RECORD CHECK. THE CONTRACTOR SHALL VERIFY THE EXACT LOCATION, BOTH HORIZONTAL AND VERTICAL, OF ALL UTILITIES THROUGH THE APPROPRIATE UTILITY COMPANIES. CALL BEFORE YOU DIG, 811 OR 1–888–344–7233.
- 2. STATE PLANE COORDINATE (HORIZONTAL DATUM): REFERENCES MASSACHUSETTS PLAN COORDINATE SYSTEM NAD83 1983, US FOOT.
- 3. STATE PLANE COORDINATE (VERTICAL DATUM): NAVD 1988. THE COORDINATE SYSTEM THAT THIS SURVEY WAS BASED UPON IS STATE PLANE NAD 88.
- 4. VERTICAL LOCATION OF SUBSURFACE UTILITY LINES ARE BASED ON ASSUMED DEPTHS USING BEST AVAILABLE INFORMATION AND ARE APPROXIMATE AND MAY VARY FROM THE ACTUAL VERTICAL LOCATIONS. BUILDING SERVICE CONNECTIONS (ELECTRIC, GAS, TELEPHONE, WATER AND SANITARY) ARE NOT SHOWN. CONTRACTOR IS TO ASSUME SERVICES ARE PRESENT TO ALL BUILDINGS.
- 5. ALL WORK SHALL BE PERFORMED WITHIN THE DESIGNATED UTILITY PROPERTY.
- 6. ALL AREAS DISTURBED BY CONSTRUCTION SHALL BE RETURNED TO THE ORIGINAL CONDITION OR BETTER AS DETERMINED BY OWNER AND IN ACCORDANCE WITH THE APPLICABLE LOCAL AND/OR STATE REQUIREMENTS.
- 7. CIVIL CONTRACTOR SHALL HAUL AWAY ALL UNUSED EXCAVATED MATERIAL TO PERMITTED SOIL DISPOSAL SITE.
- 8. CIVIL CONTRACTOR SHALL BE RESPONSIBLE FOR REPLACING AND REPAIRING ALL PAVEMENT DISTURBED DUE TO THE CONSTRUCTION. ALL REPLACEMENT AND REPAIRS SHALL BE PERFORMED IN ACCORDANCE WITH THE APPLICABLE LOCAL AND/OR STATE REQUIREMENTS.
- 9. CIVIL CONTRACTOR SHALL BE RESPONSIBLE FOR REPAIRING ANY & ALL UTILITIES AND FACILITIES DAMAGED DURING CONSTRUCTION IN ACCORDANCE WITH THE APPLICABLE UTILITY SPECIFICATION, LOCAL AND/OR STATE REQUIREMENTS.
- 10. CIVIL CONTRACTOR SHALL BE RESPONSIBLE FOR REMOVING ABANDONED CONDUIT AS REQUIRED IN ACCORDANCE WITH THE APPLICABLE LOCAL AND/OR STATE REQUIREMENTS. CUT AND CAP ABANDONED UTILITIES (DO NOT CUT GAS LINES).
- 11. CIVIL CONTRACTOR SHALL BE RESPONSIBLE FOR BUILDING TEMPORARY AND PERMANENT ACCESS ROADS. ALL TEMPORARY ACCESS ROADS WILL BE REMOVED AND ORIGINAL GRADE WILL BE RESTORED WHEN WORK IS COMPLETED.
- 12. CIVIL CONTRACTOR SHALL BE RESPONSIBLE FOR IMPLEMENTING BEST MANAGEMENT PRACTICES FOR CONTROLLING EROSION AND SEDIMENTATION.
- 13. CIVIL CONTRACTOR SHALL RESTORE GRADE TO PRE-CONSTRUCTION ELEVATIONS UNLESS OTHERWISE NOTED ON THE DRAWINGS.
- 14. DUCT BANK SHALL MAINTAIN A COVER DEPTH OF 3'-0" BELOW GRADE.
- 15. ALL VERTICAL RADII ARE 400', AND HORIZONTAL RADII ARE 500' UNLESS OTHERWISE NOTED.
- 16. DUCT BANK SHALL MAINTAIN MINIMUM HORIZONTAL CLEARANCE OF 1'-0" AND A MINIMUM VERTICAL CLEARANCE OF 1'-0" OVER OR UNDER EXISTING UTILITIES, UNLESS OTHERWISE SHOWN ON DRAWINGS.

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	CHAIN LINK FENCE
⊡ CB/DH	CONCRETE BOUND W/ DRILL HOLI
FND	FOUND
IR/IP 🔘	IRON ROD/PIPE
\$	LIGHT POLE
∂ ^{UP}	UTILITY POLE
	CORRUGATED METAL PIPE
CBN	CATCH BASIN
RCP	REINFORCED CONCRETE PIPE
EOP	EDGE OF PAVEMENT
GP 🔘	GATE POST
	SIGN
G	GAS
——— E ———	UNDERGROUND ELECTRIC
—— ОНШ ——	OVERHEAD WIRES
2−3 •	WETLAND FLAGS
	100' WETLAND BUFFER ZONE



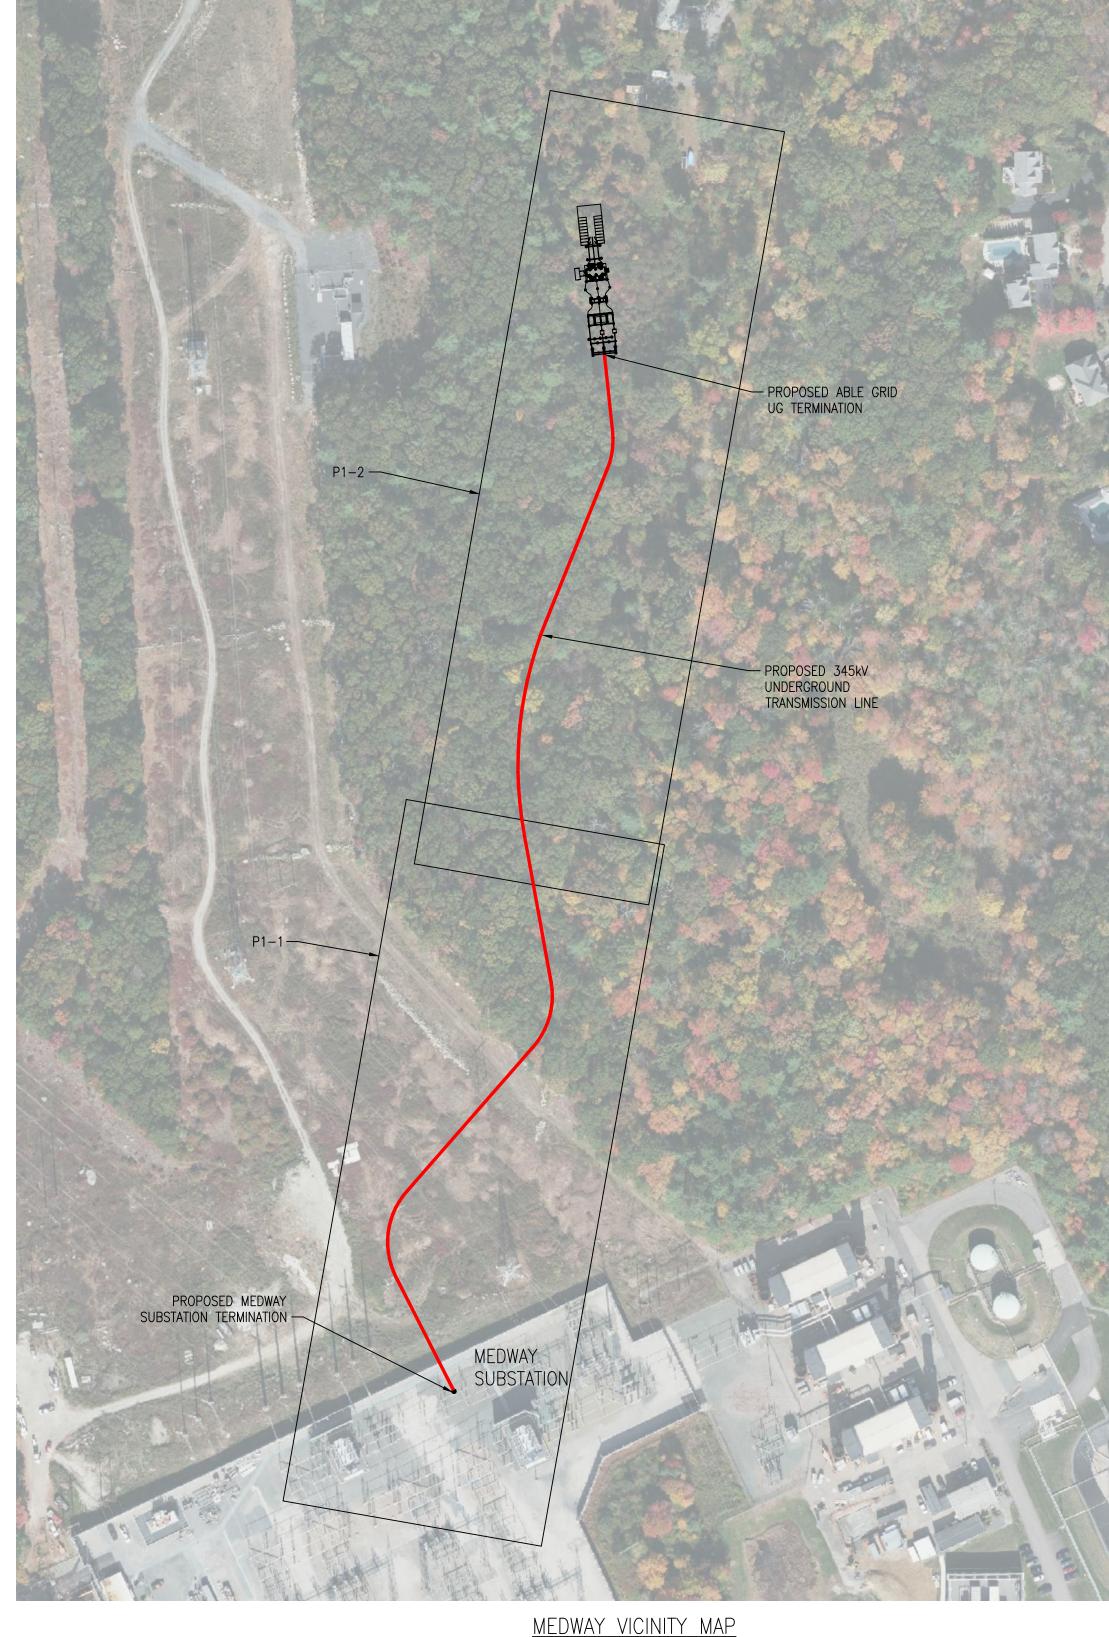

MEDWAY VICINITY N.T.S.

now what's below. Call before you dig.


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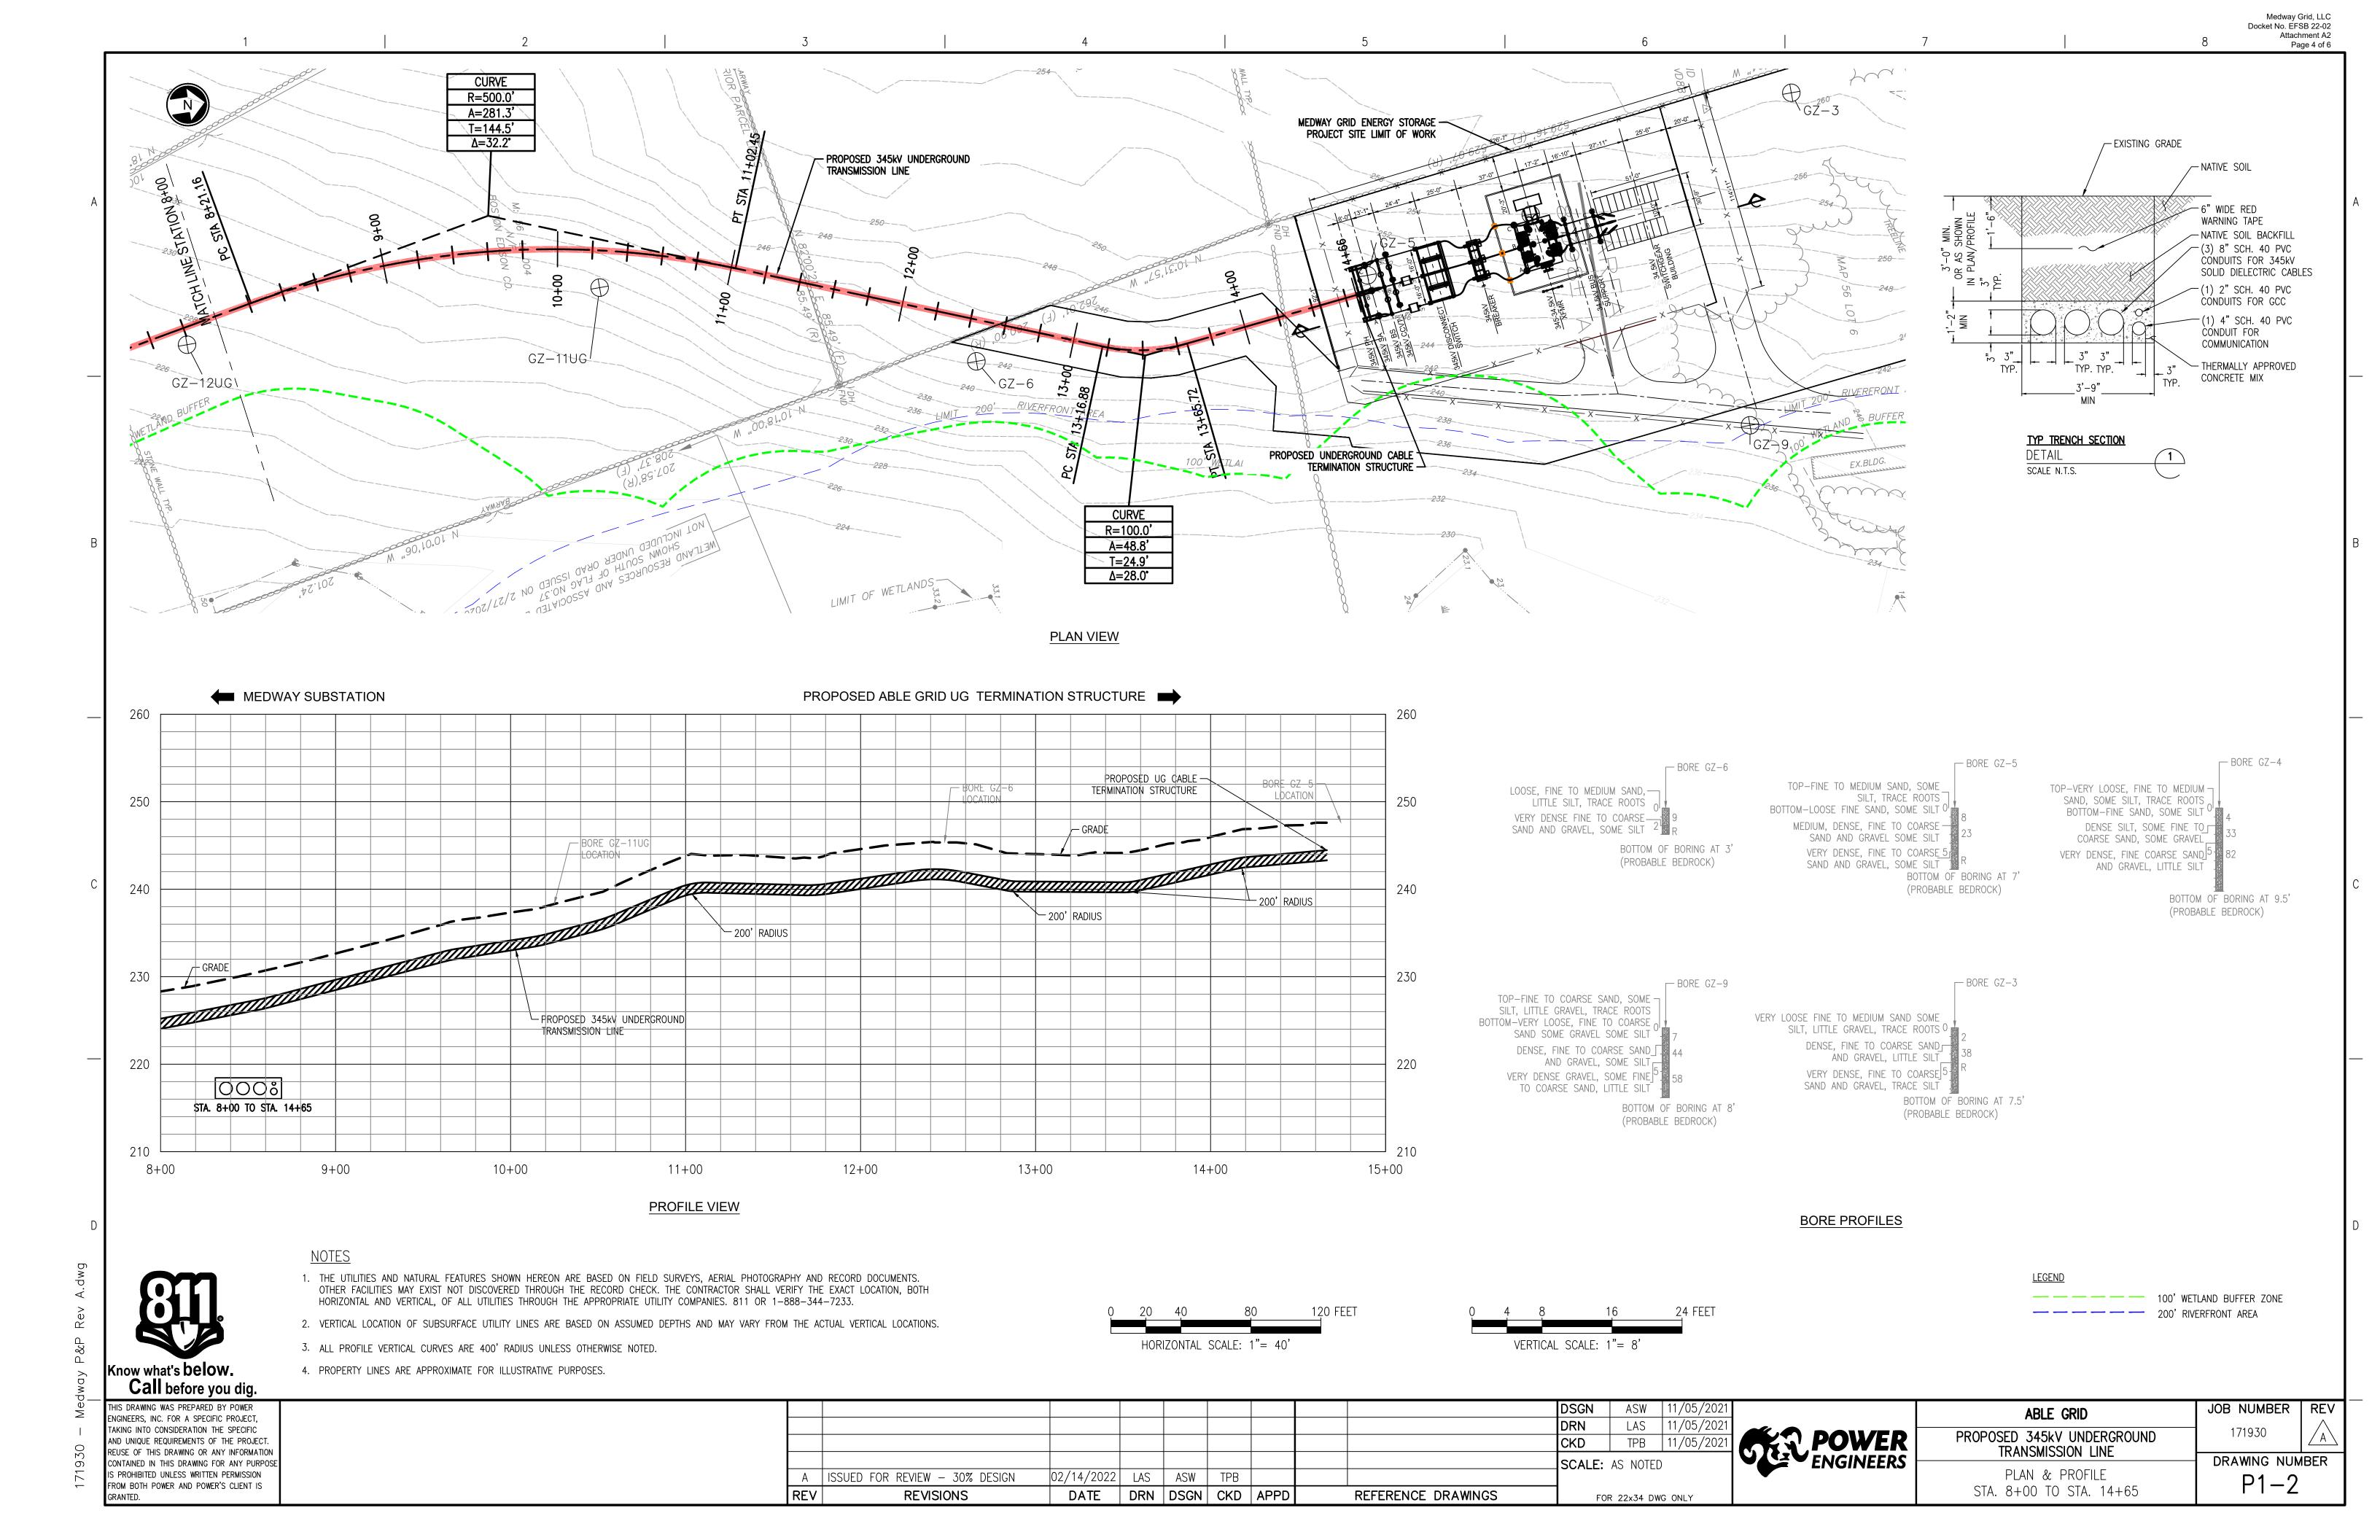
— — — — 200' RIVERFRONT AREA

POWER ENGINEERS	PROPO
ENGINEERS	LEGEN

ABLE GRID	JOB NUMBER	
PROPOSED 345kV UNDERGROUND TRANSMISSION LINE	171930	4
TITATIONIOSION LINE	DRAWING NUM	18
LEGEND AND DRAWING MANIFEST	G0-2	

930 – Medway Cover-Manifest.dwg



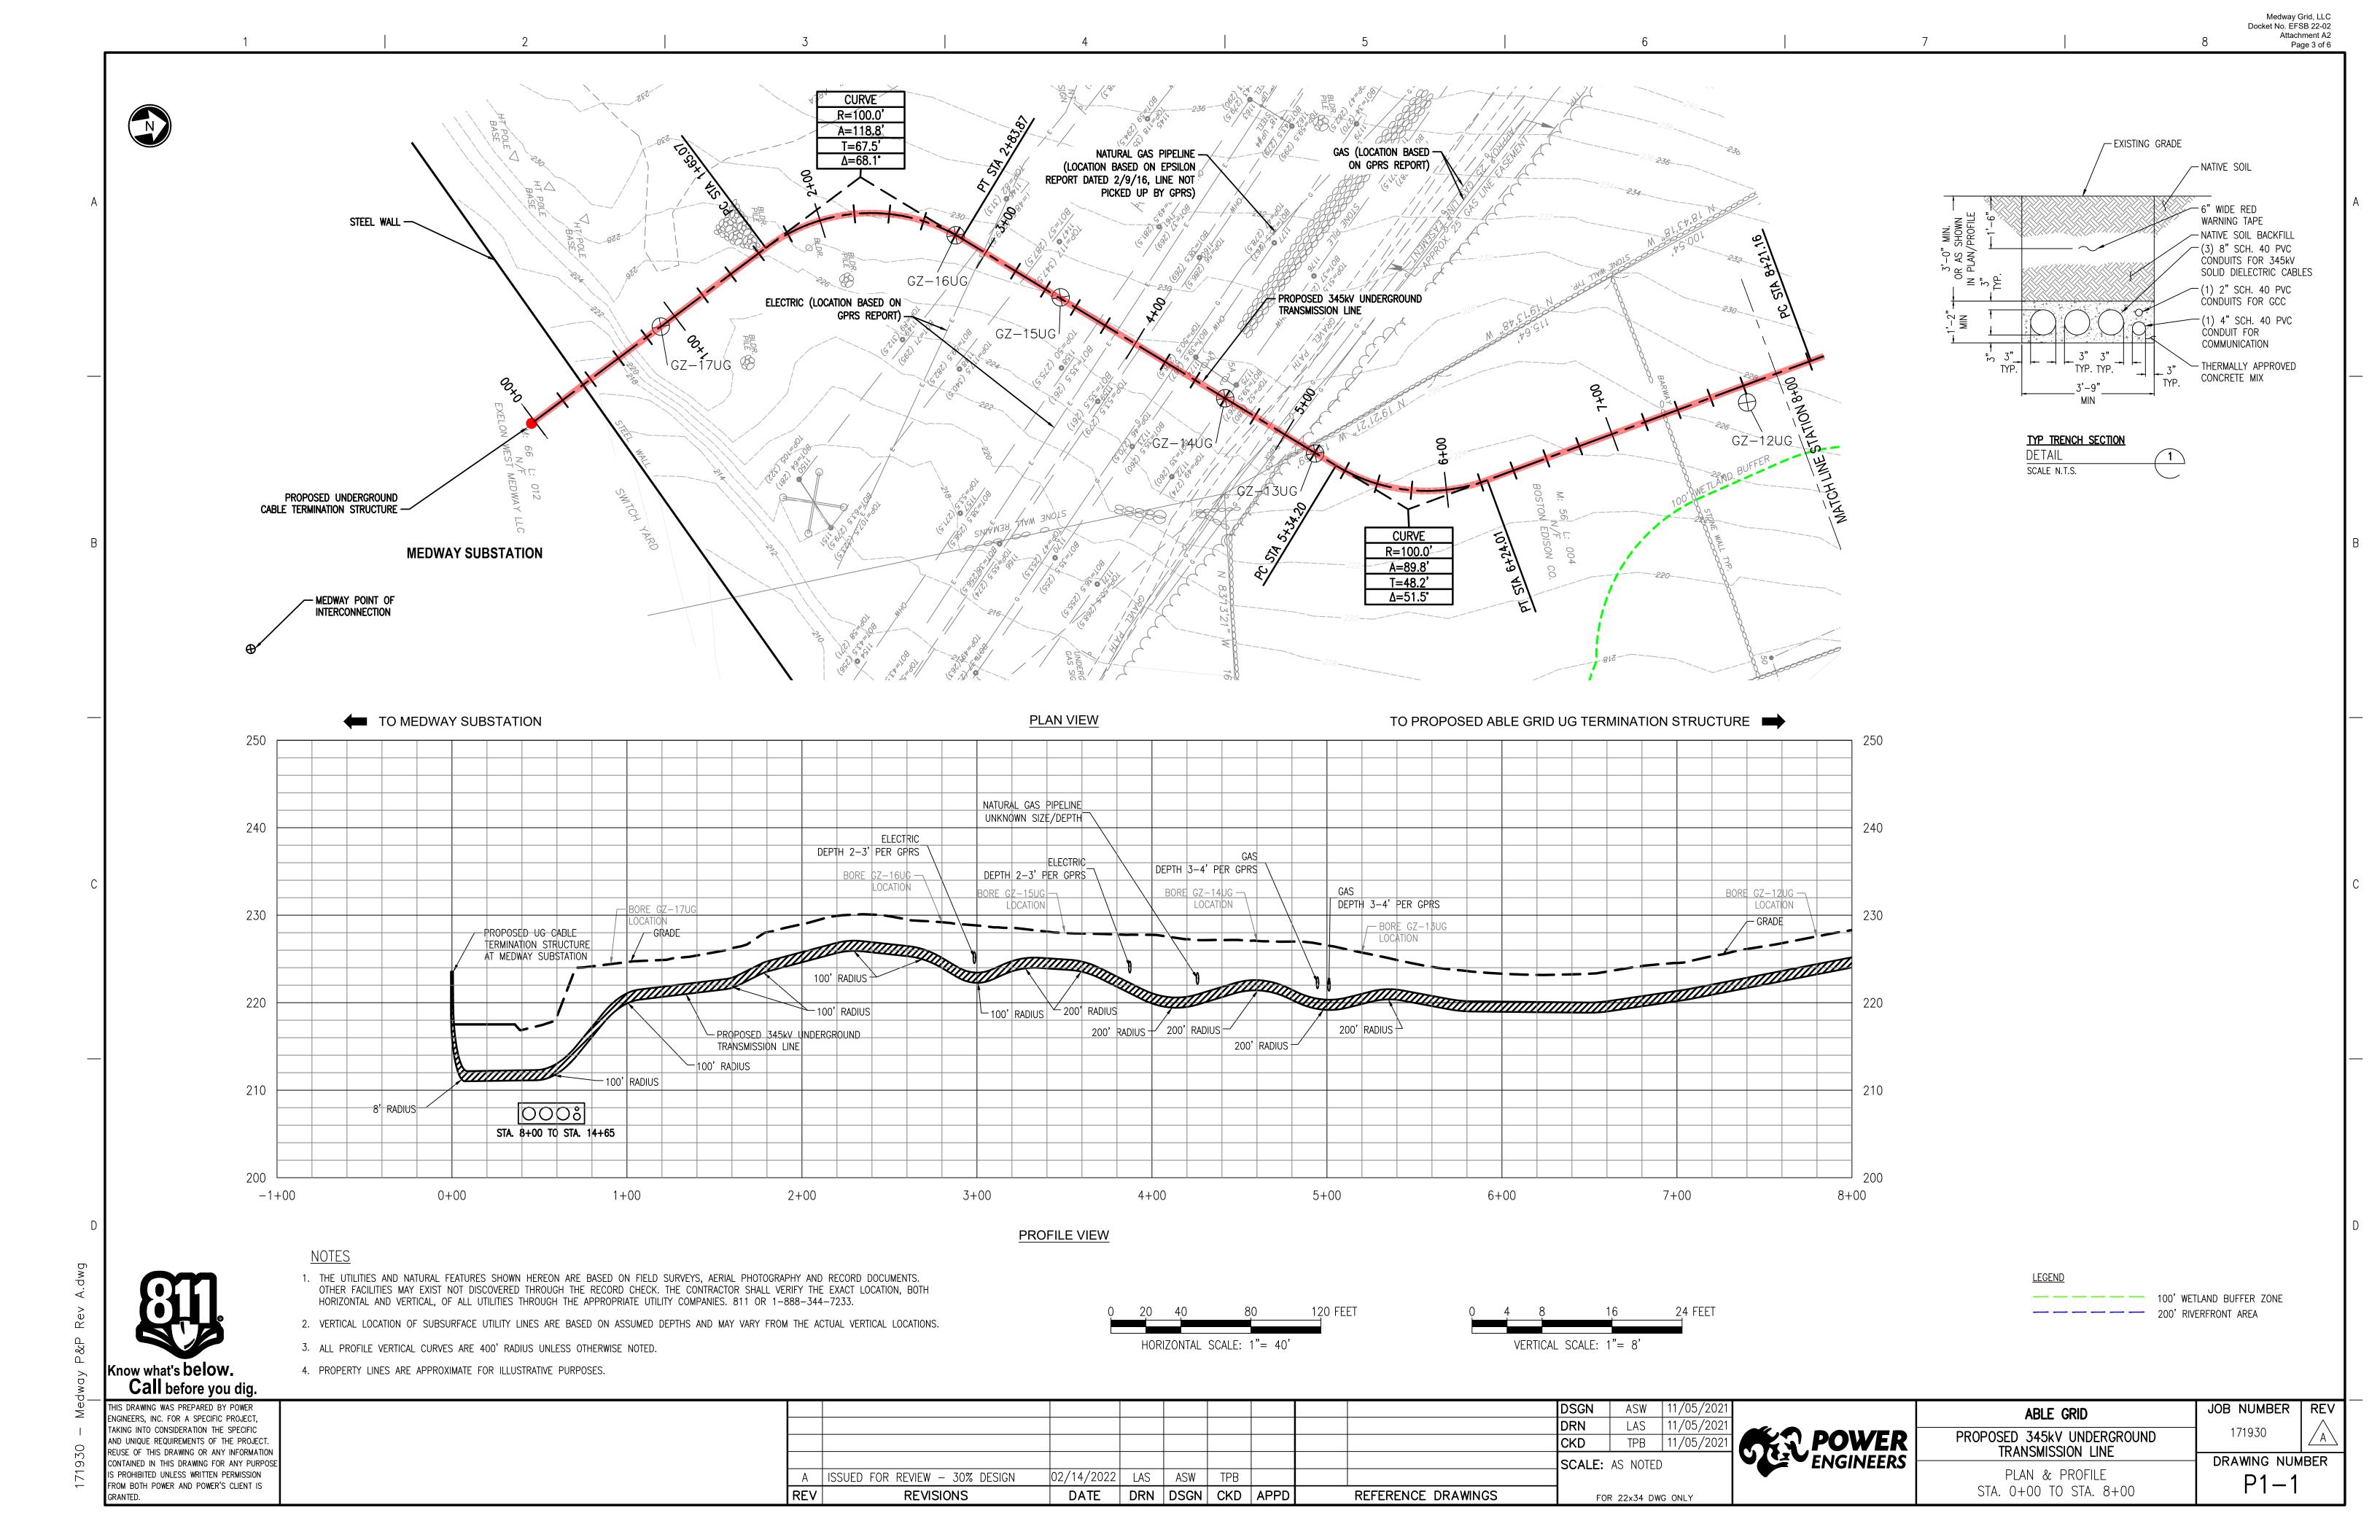

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PROPOSED 25' WIDE PERMANENT EASEMENT ACREAGE: 0.808 ACRES MEDWAY GRID ENERGY STORAGE PROJECT SITE LIMIT OF WORK PROPOSED 345kV UNDERGROUND TRANSMISSION LINE STEEL WALL PROPOSED 345kV UNDERGROUND TRANSMISSION LINE PROPOSED UNDERGROUND CABLE TERMINATION STRUCTURE -PROPOSED TEMPORARY EASEMENT ACREAGE: 0.025 ACRES MEDWAY SUBSTATION PROPOSED UNDERGROUND CABLE TERMINATION - MEDWAY POINT OF INTERCONNECTION STRUCTURE

Know what's below. Call before you dig.

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<u>NOTES</u>

- 1. THE UTILITIES AND NATURAL FEATURES SHOWN HEREON ARE BASED ON FIELD SURVEYS, AERIAL PHOTOGRAPHY AND RECORD DOCUMENTS.
 OTHER FACILITIES MAY EXIST NOT DISCOVERED THROUGH THE RECORD CHECK. THE CONTRACTOR SHALL VERIFY THE EXACT LOCATION, BOTH HORIZONTAL AND VERTICAL, OF ALL UTILITIES THROUGH THE APPROPRIATE UTILITY COMPANIES. 811 OR 1-888-344-7233.
- 2. VERTICAL LOCATION OF SUBSURFACE UTILITY LINES ARE BASED ON ASSUMED DEPTHS AND MAY VARY FROM THE ACTUAL VERTICAL LOCATIONS.
- 3. ALL PROFILE VERTICAL CURVES ARE 400' RADIUS UNLESS OTHERWISE NOTED.
- 4. PROPERTY LINES ARE APPROXIMATE FOR ILLUSTRATIVE PURPOSES.


HORIZONTAL SCALE: 1"= 60'

 100' WETLAND BUFFER ZONE
 200' RIVERFRONT AREA

REV	REVISIONS	DATE	DRN	DSGN	CKD	APPD	REFERENCE DRAWINGS	FOR 22	x34 DW	/G ONLY	
Α	ISSUED FOR REVIEW - 30% DESIGN	02/14/2022	LAS	ASW	TPB						
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POWER ENGINEERS	PROPOSED 345kV UNDERGROUND TRANSMISSION LINE	171930	
ENGINEERS	TRANSMISSION LINE	DRAWING NUM	1BEI
•	EASEMENT OVERVIEW	P2-1	

<u>LEGEND</u>

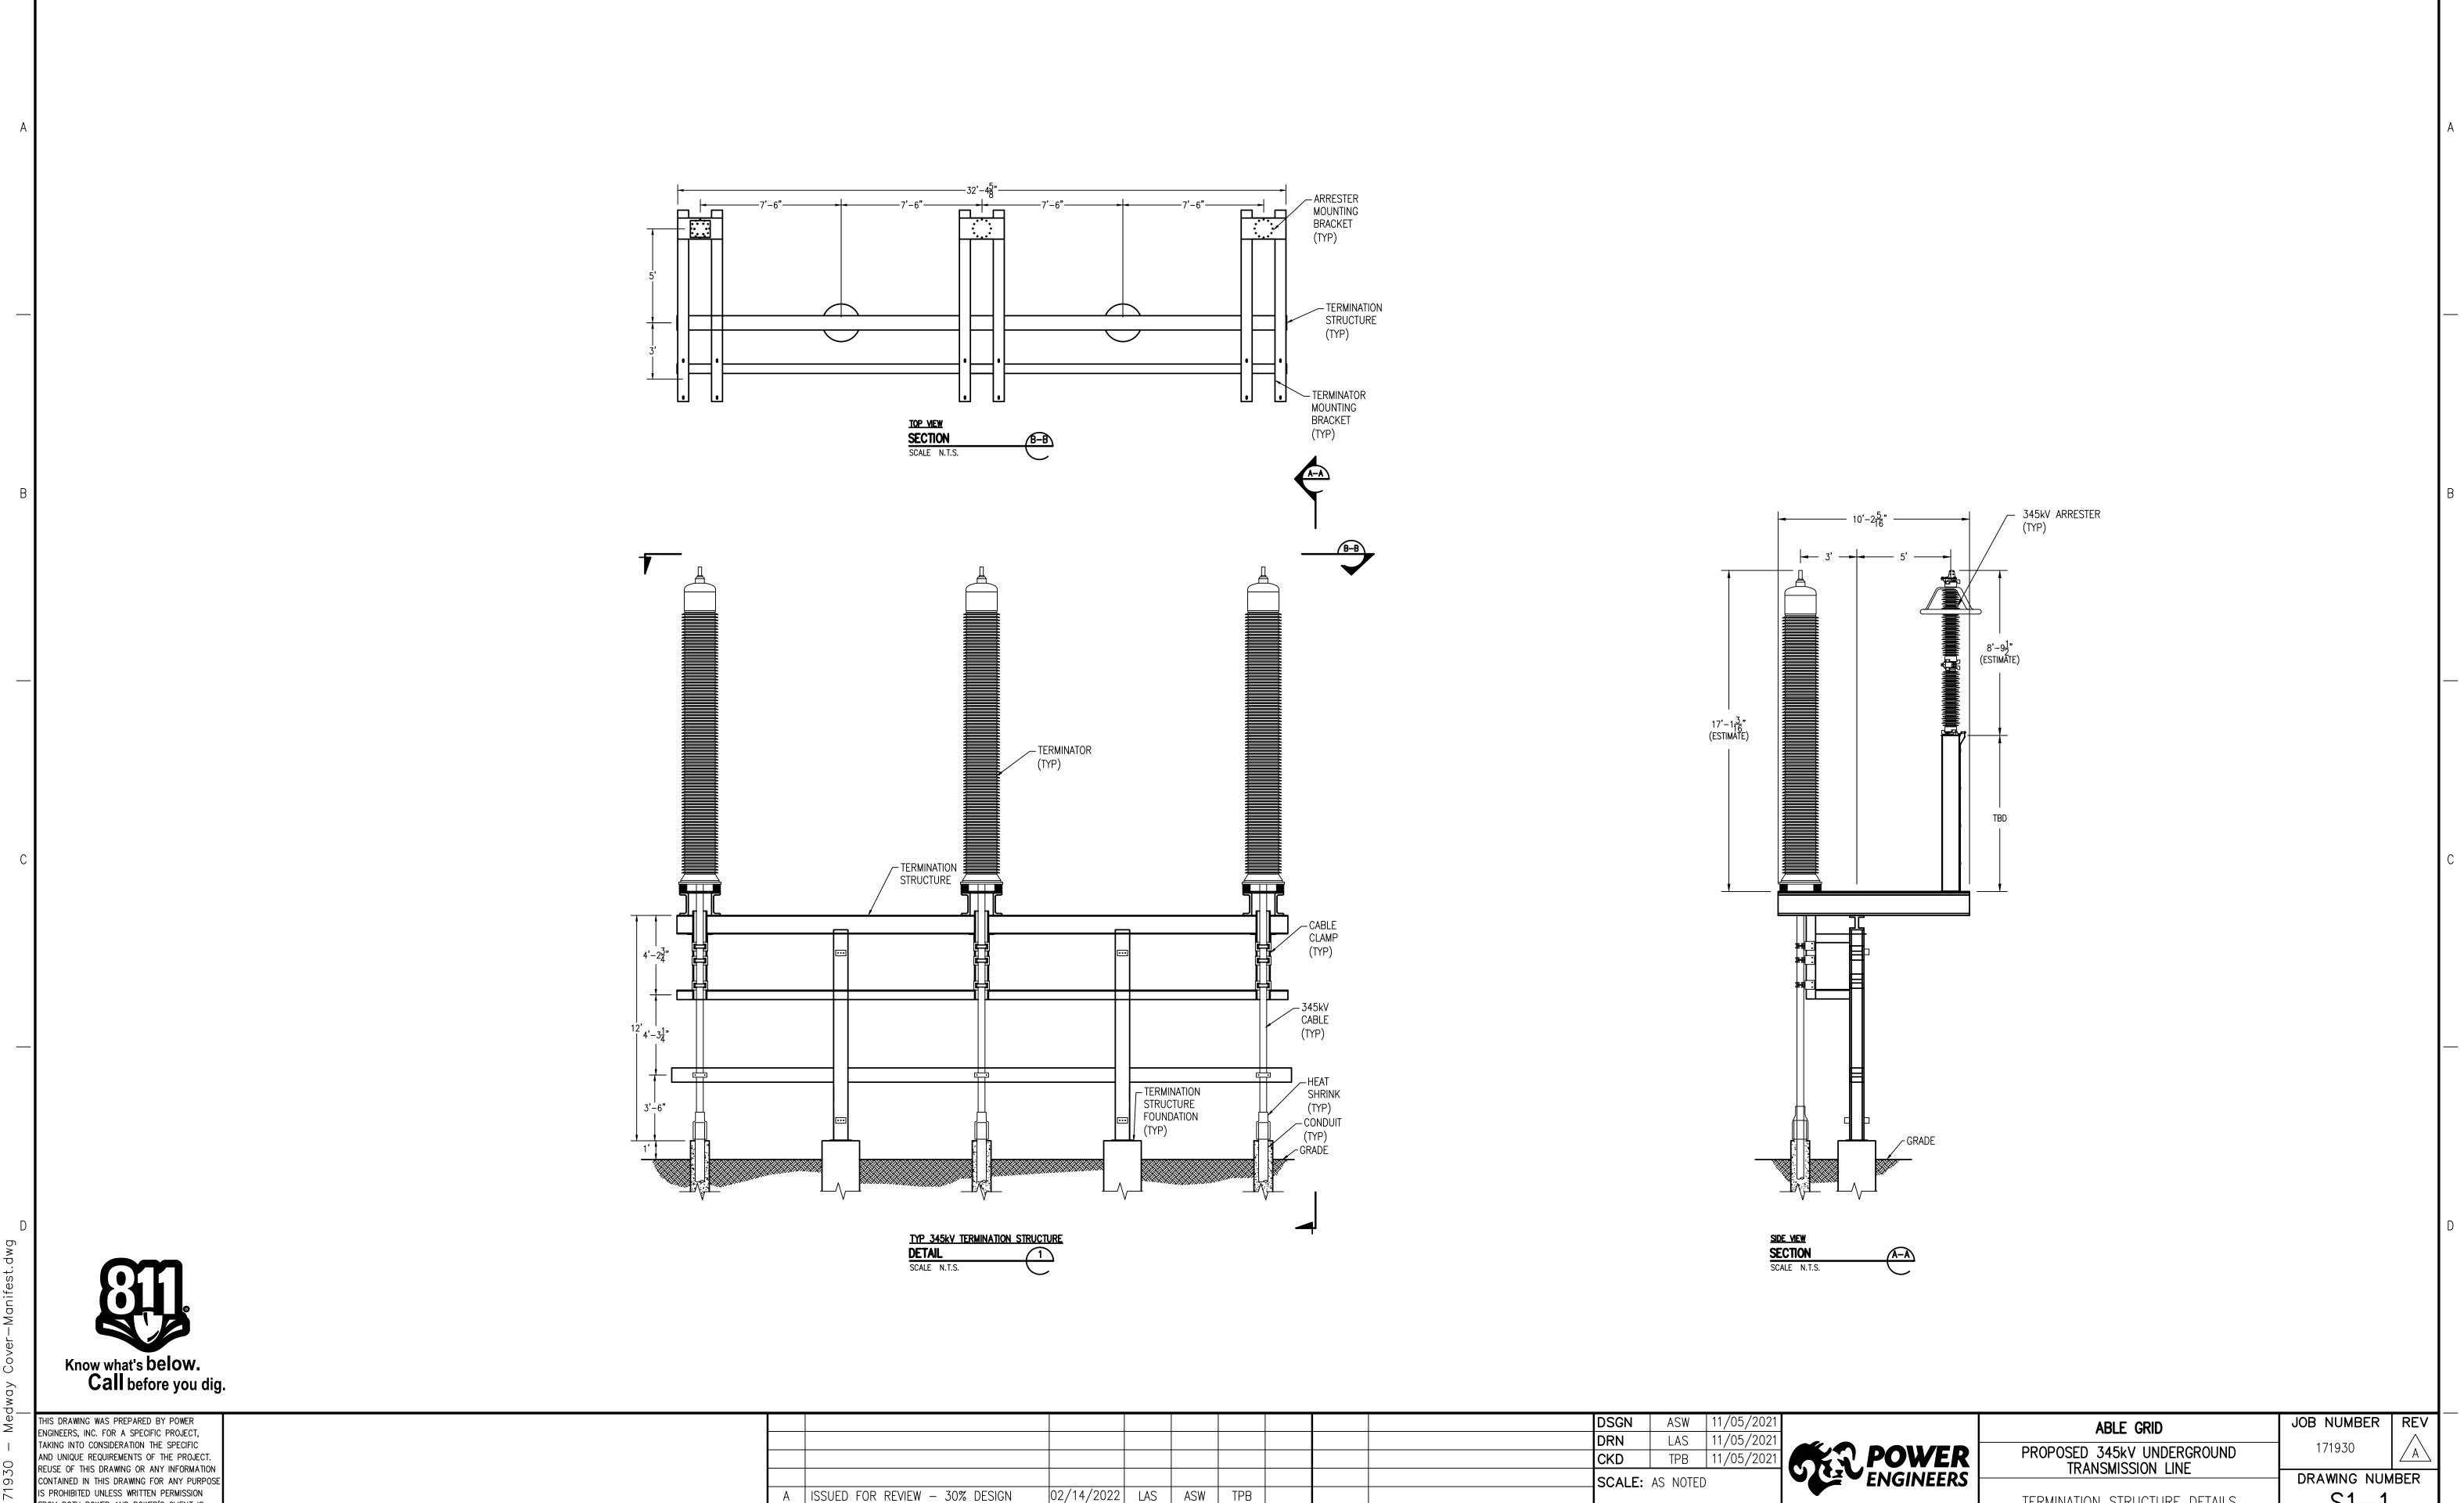

02/14/2022 LAS ASW TPB

DATE DRN DSGN CKD APPD

REFERENCE DRAWINGS

FOR 22x34 DWG ONLY

A ISSUED FOR REVIEW - 30% DESIGN

REVISIONS

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S1-1

TERMINATION STRUCTURE DETAILS

FROM BOTH POWER AND POWER'S CLIENT IS

GRANTED.